

VALLEY RD
PADSTOW HEIGHTS

PROPOSED SWIMMING POOLS & CABANAS






DRAWING SCHEDULE

- 01 FRONT PERSPECTIVE/CONTENTS
- 02 SITE PLAN
- 03 SEDIMENT CONTROL PLAN
- 04 CUT/FILL PLAN
- 05 CABANA PLANS AND SECTIONS
- 06 SWIMMING POOL DETAILS



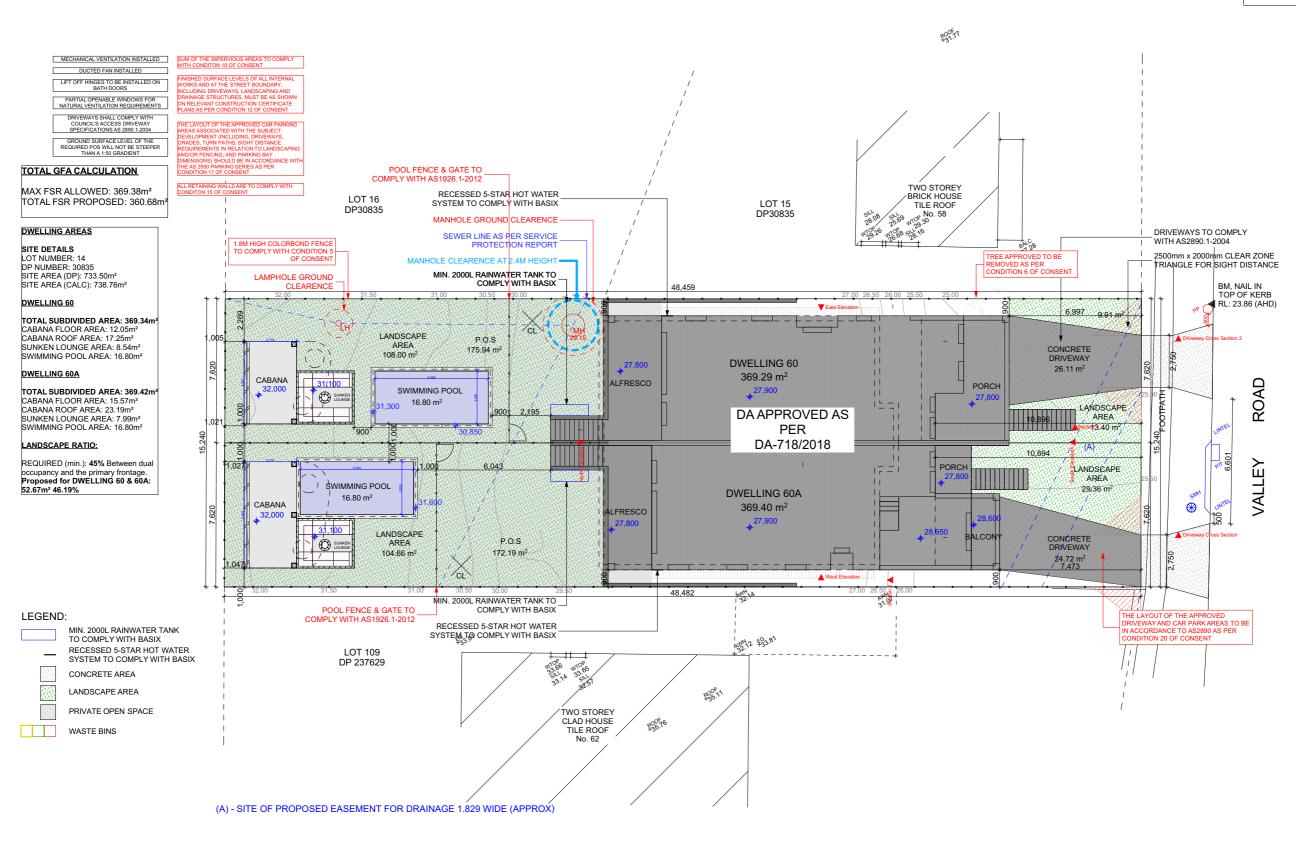

LEGEND

REDUCED LEVEL STOVE/OVEN COOKTOP SMOKE ALARM WASHING MACHINE DRYER FRIDGE DW DISHWASHER
DP DOWNPIPE
T.O.R TOP OF ROOF DISHWASHER DOWNPIPE

W.I.R WALK IN ROBE
WATER FLOW DIRECTION ROOF PITCH FLOOR WASTE LINEN CUPBOARD P.O.S PRIVATE OPEN SPACE LP LIGHT POLE

B.I.R BUILD IN ROBE

- THE BUILDER SHALL CHECK AND VERIFY ALL DIMENSIONS AND VERIFY ALL ERRORS AND OMISSION TO THE ARCHITECT. DO NOT SCALE THE DRAWINGS DRAWINGS SHALL NOT BE USED FOR CONSTRUCTIO PURPOSES UNTIL ISSUED BY THE ARCHITECT FOR CONSTRUCTION.

CHECK ALL DIMENSIONS ON THE JOB PRIOR TO COMMENCEMENT OF KITCHEN DRAWINGS OR FABRICATION. ANY DISCREPENCIES TO BE REFERED TO THE ARCHITECT/ENGINEER/ DESIGNER PRIOR TO COMMENCEMENT OF WORK.

LOCAL COUNCIL AND AUSTRALIAN STANDARDS

ALL DRAWINGS SHOULD BE READ IN CONJUCTION WIT ARCHITECTURAL SPECIFICATION AND SCHEDULES,

-TIMBER USED SHALL BE IN ACCORDANCE WITH AS 1684 OF TIMBER FRAMING CODE.

PROVIDE 50mm SETDOWN TO SLAB TO WET AREA GROUND FLOOR).

WITH AS3786, ALARMS TO BE POSITIONED ON THE CEILING AND SET BACK A MINIMUM DISTANCE 300mm FROM ANY WALL.

-ALL WINDOW SIZES ARE APPROXIMATE ONLY AND FINA SIZES MUST BE DETERMINED BY THE BUILDER

CONCEALED METAL FASTENED SHEET TO BE USED FOR

ALL SKILLION ROOF COVERING REVISION A - CONCEPT REVISION A - CONCEPT K.N
REVISION B - FINALISED PLANS K.N

REVISION D - FINALISED PLANS	K.N	21/03/24		
VE VISION C - CONCEPT	IX.IN	10/03/24		

GROUP PTY LT Contact: 0433 375 386

CAMPBELL HILL

BUILDING DESIGNERS

Client

MICK

Project Name DUAL OCCUPANCY

60 VALLEY RD, PADSTOW HEIGHTS

- Site Plan


6455

Scale: As Noted Designed By: M.N

 $1:2\underline{00}|_{\substack{\text{Project No:}\\ \text{\textbf{J0360}}}}$

02

Site Plan

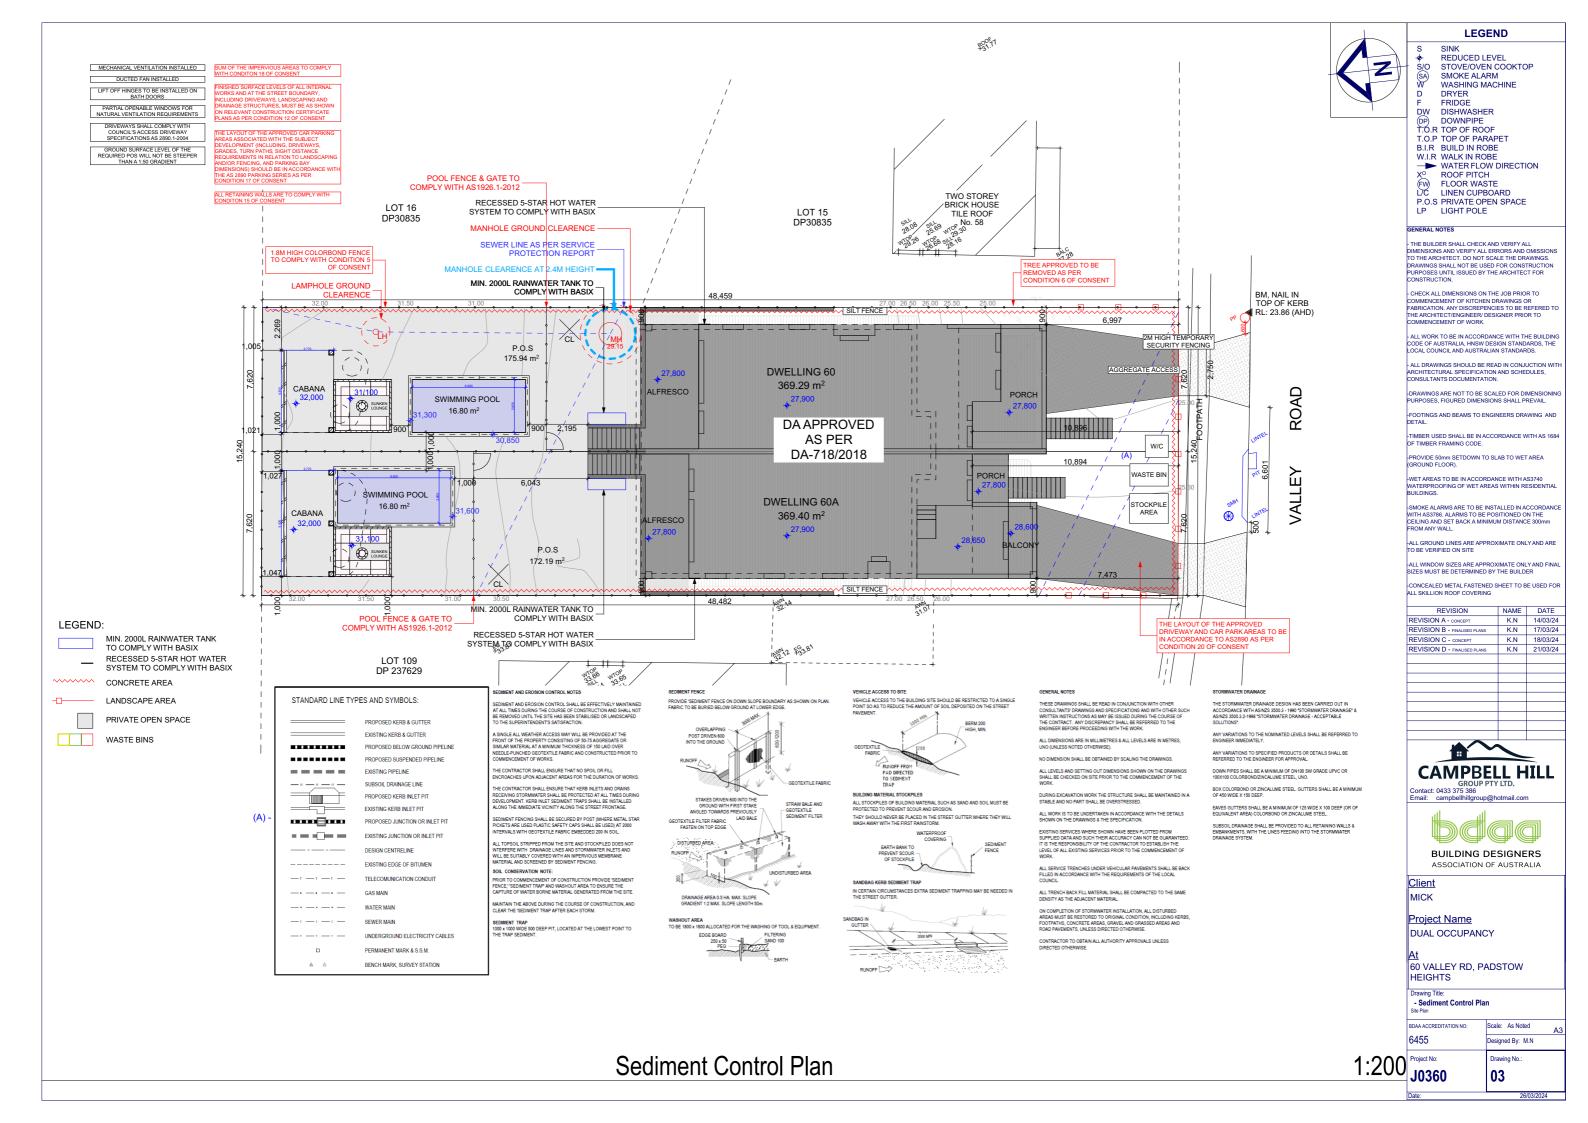



LEGEND

SINK REDUCED LEVEL STOVE/OVEN COOKTOP SMOKE ALARM WASHING MACHINE DRYER FRIDGE DW DISHWASHER
DP DOWNPIPE
T.O.R TOP OF ROOF
T.O.P TOP OF PARAPET

B.I.R BUILD IN ROBE

BJ.I.R BUILD IN ROBE
W.I.R WALK IN ROBE

WATER FLOW DIRECTION
X° ROOF PITCH
FW FLOOR WASTE
LIC LINEN CUPBOARD
P.O.S PRIVATE OPEN SPACE
LP LIGHT POLE

GENERAL NOTES

THE BUILDER SHALL CHECK AND VERIFY ALL DIMENSIONS AND VERIFY ALL ERRORS AND OMISSION TO THE ARCHITECT. DO NOT SCALE THE DRAWINGS. DRAWINGS SHALL NOT BE USED FOR CONSTRUCTION PURPOSES UNTIL ISSUED BY THE ARCHITECT FOR CONSTRUCTION.

CHECK ALL DIMENSIONS ON THE JOB PRIOR TO COMMENCEMENT OF KITCHEN DRAWINGS OR FABRICATION. ANY DISCREPENCIES TO BE REFERED TO THE ARCHITECT/ENGINEERY DESIGNER PRIOR TO COMMENCEMENT OF WORK.

- ALL WORK TO BE IN ACCORDANCE WITH THE BUILDING CODE OF AUSTRALIA, HNSW DESIGN STANDARDS, THE LOCAL COUNCIL AND AUSTRALIAN STANDARDS.

- ALL DRAWINGS SHOULD BE READ IN CONJUCTION WIT ARCHITECTURAL SPECIFICATION AND SCHEDULES, CONSULTANTS DOCUMENTATION.

-FOOTINGS AND BEAMS TO ENGINEERS DRAWING AND DETAIL.

-TIMBER USED SHALL BE IN ACCORDANCE WITH AS 1684 OF TIMBER FRAMING CODE. -PROVIDE 50mm SETDOWN TO SLAB TO WET AREA (GROUND FLOOR).

-WET AREAS TO BE IN ACCORDANCE WITH AS3740 WATERPROOFING OF WET AREAS WITHIN RESIDENTIA BUILDINGS.

SMOKE ALARMS ARE TO BE INSTALLED IN ACCORDANCE WITH AS3786. ALARMS TO BE POSITIONED ON THE CELLING AND SET BACK A MINIMUM DISTANCE 300mm FROM ANY WALL.

-ALL WINDOW SIZES ARE APPROXIMATE ONLY AND FINA SIZES MUST BE DETERMINED BY THE BUILDER

-CONCEALED METAL FASTENED SHEET TO BE USED FOR ALL SKILLION ROOF COVERING

REVISION	NAME	DATE
REVISION A - CONCEPT	K.N	14/03/24
REVISION B - FINALISED PLANS	K.N	17/03/24
REVISION C - CONCEPT	K.N	18/03/24
REVISION D - FINALISED PLANS	K.N	21/03/24





Client MICK

Project Name DUAL OCCUPANCY

At 60 VALLEY RD, PADSTOW HEIGHTS

Drawing Title:
- Cut/Fill Plan

Scale: As Noted Designed By: M.N

6455

1:200 Project No: **J0360**

04

Cut/Fill Plan

250**

250_{**}

CUT 8.54 m²

cur/ 7.99 m²

LEGEND: сит FILL

RETAINING WALLS

♦ 00,000 PROPOSED NEW CUT LEVEL

• 00,000 PROPOSED TOP OF RETAINING WALLS

cur

/20/48/m²/

20.48 m²

,600

27.555

9,967

163.71 m

9,967

18,243

18,213


27.00 26.50 26.00 25.50


CUT 25.42 m²

DA APPROVED AS PER DA-718/2018

CUT 44.00 m²




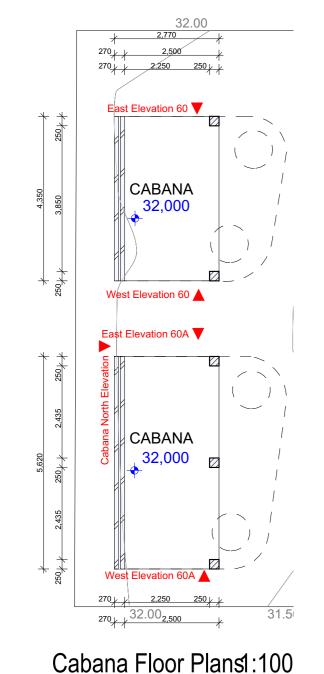

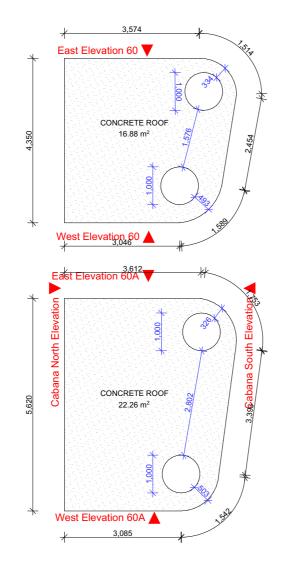

T.O.R R.L. 34.700 Ceiling R.L. 34.500 Ground Slab R.L. 32.000

Cabana North Elevation

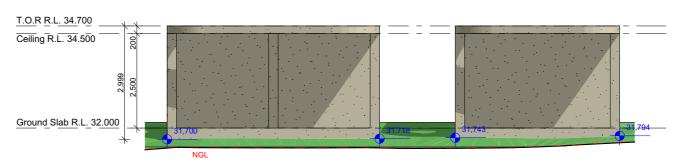



Cabana South Elevation



Cabana Roof Plan1:100

East Elevation 60 1:100 East Elevation 60A 1:100

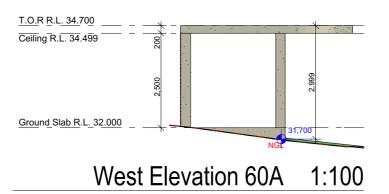

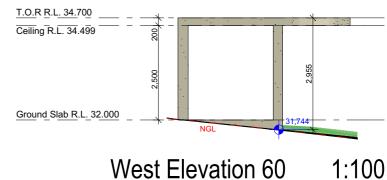

LEGEND SINK REDUCED LEVEL

STOVE/OVEN COOKTOP SMOKE ALARM WASHING MACHINE DRYER FRIDGE

DW DISHWASHER
DP DOWNPIPE
T.O.R TOP OF ROOF
T.O.P TOP OF PARAPET B.I.R BUILD IN ROBE W.I.R WALK IN ROBE

WATER FLOW DIRECTION

X° ROOF PITCH

(FW) FLOOR WASTE

L'C LINEN CUPBOARD

P.O.S PRIVATE OPEN SPACE

LP LIGHT POLE

CHECK ALL DIMENSIONS ON THE JOB PRIOR TO COMMENCEMENT OF KITCHEN DRAWINGS OR FABRICATION. ANY DISCREPENCIES TO BE REFERED THE ARCHITECT/ENGINEER/ DESIGNER PRIOR TO

WITH AS3786, ALARMS TO BE POSITIONED ON THE CEILING AND SET BACK A MINIMUM DISTANCE 300mm FROM ANY WALL.

CONCEALED METAL FASTENED SHEET TO BE USED FO

REVISION	NAME	DATE		
REVISION A - CONCEPT	K.N	14/03/24		
REVISION B - FINALISED PLANS	K.N	17/03/24		
REVISION C - CONCEPT	K.N	18/03/24		
REVISION D - FINALISED PLANS	K.N	21/03/24		



BUILDING DESIGNERS

MICK

Project Name DUAL OCCUPANCY

60 VALLEY RD, PADSTOW

- Cabana Plans and Sections

J0360

05

LEGEND

SINK REDUCED LEVEL STOVE/OVEN COOKTOP SMOKE ALARM WASHING MACHINE DRYER FRIDGE DW DISHWASHER

DOWNPIPE

T.O.R TOP OF ROOF

T.O.P TOP OF PARAPET

B.I.R BUILD IN ROBE

W.I.R WALK IN ROBE

WATER FLOW DIRECTION

ROOF PITCH
FW FLOOR WASTE
LTC LINEN CUPBOARD
P.O.S PRIVATE OPEN SPACE
LP LIGHT POLE

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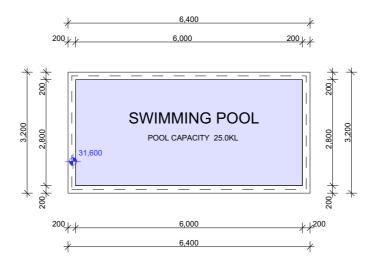
Client MICK

> Project Name DUAL OCCUPANCY


At 60 VALLEY RD, PADSTOW HEIGHTS

06

DWELLING 60A




SWIMMING POOL PLAN

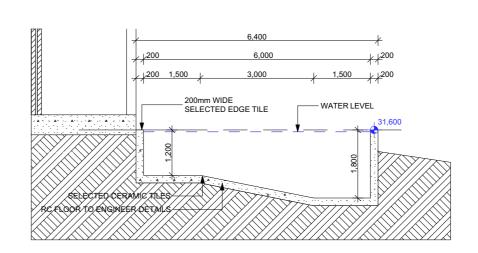


SWIMMING POOL SECTION

SWIMMING POOL TO BE IN ACCORDANCE WITH AS1926 OF BCA AND ALL OTHER RELEVANT REGULATIONS

DWELLING 60

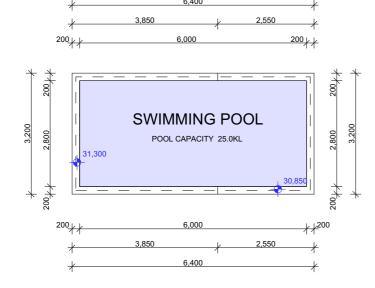

SWIMMING POOL PLAN

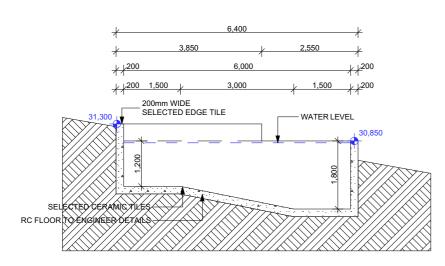

SWIMMING POOL SECTION

SWIMMING POOL TO BE IN ACCORDANCE WITH AS1926 OF BCA AND ALL OTHER RELEVANT REGULATIONS